

Mr. Sotir Papalilo Westwood Associates LLC PO Box 250 Shrewsbury, MA 10545

Catherine Oranchak, LA 122 Sunset Rd. Arlington, MA 02474 RECEIVED

APK 122021

Zoning Board of Appeals

RE: Tree Health Assessment Report: 23 Prentice Street, Grafton, Massachusetts

Sotir and Catherine,

This report is a follow up to our inspection and assessment of all woodland trees between the property boundaries of 23 Prentice Street and the work limits for the proposed Prentice Place housing development. As you recall, we met at the site on March18 with members of your development team and representative from the Town of Grafton to identify the subject area and any trees that should not be retained during construction.

Following are the results of the assessment, a site plan of the property with the trees to be removed identified, tree inventory data and photographs of the identified trees.

Thanks for the opportunity to assist you with this project. Please do not hesitate to contact me if you have any questions or need additional services.

Best regards,

David Hawkins, Consulting Arborist

Urban Forestry Solutions, Inc.

2021 APR 12 AH 8: 4.7

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Tree Assessment Summary


Approximately 48 trees are in the wooded area between the property boundary of 23 Prentice Street and the limit of work line delineated on the Site Development Plan for Prentice Place submitted by Hannigan Engineering. Of the 48 trees, 11 were determined to be dead, structurally unsound, or white ash (*Fraxinus americana*), a species that is or will be infested with the Emerald Ash Borer (*Agrilus planipennis*) – an invasive insect that is fatal to all ash species and found in most Massachusetts towns. Other species on the removal list are black cherry (*Prunus serotina*), white oak (*Quercus alba*), butternut (*Juglans cinerea*), sugar maple (*Acer saccharum*) and boxelder (*Acer negundo*).

The trees to be removed are marked with an orange paint dot on the side of the tree facing the proposed development area. Seven trees are in the northwest corner of the property, two in the southwest corner and two along the south border just east of the utility easement right of way. One tree in this area is marked with red and white ribbon and is to be retained. All other trees along the east and north borders are within the work zone or were assessed as healthy.

The site plan on the next page shows the 11 trees marked for removal (green circles) with numbers corresponding to the data sheet on page 4. Note, since all marked trees were in the west and south portions of the plan, only that portion of the plan is shown. Photographs of the 11 trees follows on page 5.




Site Plan (not to scale)

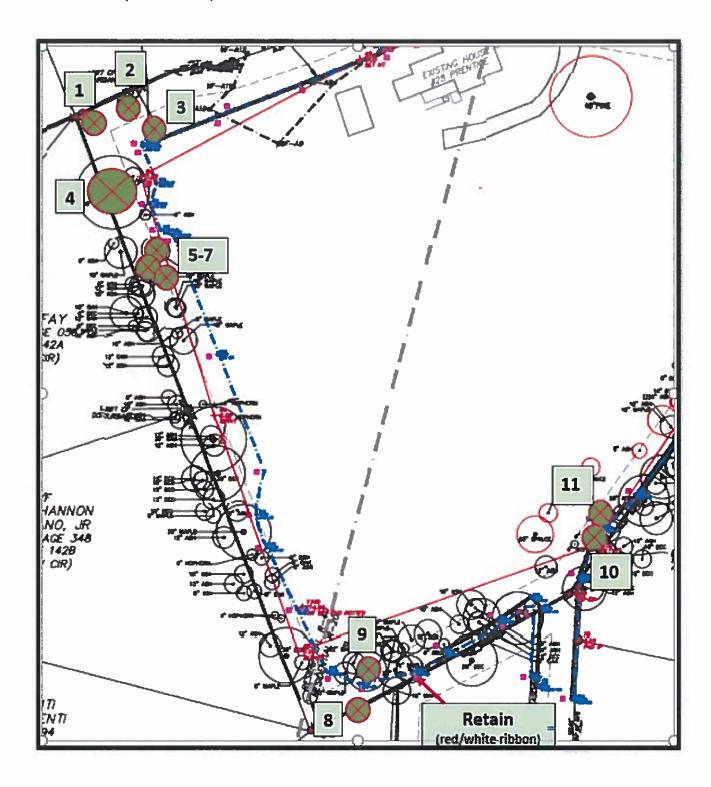

Inventory Data

No.	Species	DBH Cal.	Est. Tree Hht	Cond	Location	Notes
1	White Ash	15	45	Dead	Northwest corner	Added to plan
2	White Ash	10	35	Dead	Northwest corner	Added to plan
3	Black Cherry	10	30	Dead	Northwest corner	Added to plan
4	White Oak	43.5	65	Poor	Northwest property line	Large, old tree. Significant decay and weak branch attachment north side. 30 to 40 percent dead
5	Butternut	16.5	50	Fair	Northwest property line	Decay at base of tree. Lean to east and proposed construction
6	White Ash	9	40	Dead	Northwest property line	Next to wall. Note nearby ash on abutting property dead also
7	Sugar Maple	9	40	Fair	Northwest property line	Decay at base of tree. Lean to east and proposed construction
8	Boxelder	9	25	Poor	Southwest property line	45 degree lean and all weight toward and over house.
9	White Ash	28	65	Poor	Southwest property line	Decay at base. One leader dead broken off. Weak branch attachment
10	White Ash	15.5	50	Fair to Good	South property line. East of util. easement	Tree is alive but infested with Emerald Ash Borer.
11	White Ash	5	25	Poor	South property line. East of util. easement	Poor form. Broken top. ALB presence likely

Photographs of Trees to be Removed

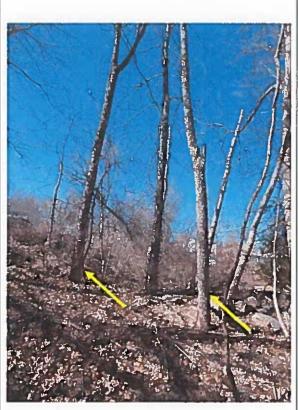



TREES #1 & #2

TREE #3





TREE #4. Note decayed area and weak branch attachment (arrow)








TREE #5



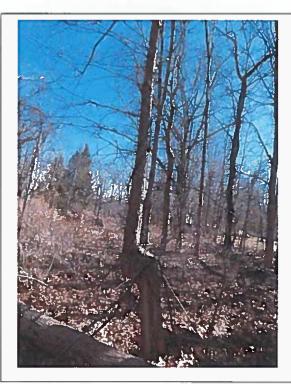




TREE #7

TREE #8






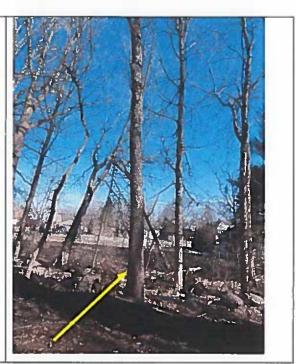

TREE #9

TREE #10

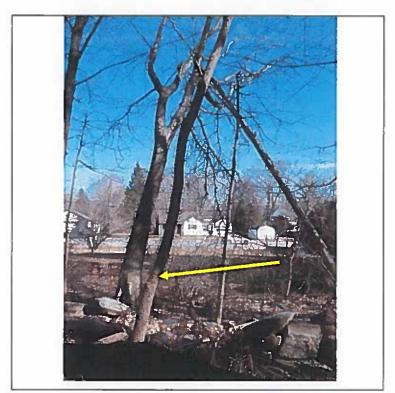

TREE #11

Disclaimer

By the nature or their size, weight, miscellaneous structure issues, constant exposure to the weather and the elements, and susceptibility to insect's pest and decay organisms, trees always pose an inherent degree of risk of breakage or structural failure.

Recommendations made by Urban Forestry Solutions, Inc. are intended to minimize, reduce, or eliminate hazardous conditions associated with trees. However, there is not, and can never be, any guarantee or certainty that these recommendations will totally correct unsafe conditions or prevent future failure of a tree.

The recommendations carried out as stated should reduce the risk, but they cannot completely eliminate the risk (except when the tree is removed), especially in the event of future growth, further deterioration, subsequent insect attacks, extreme weather conditions, or other eternal factors such as lightning strikes vehicular damage, or other acts of God or man.

Certification

I certify the statements in this report are, to the best of my knowledge, true, accurate and represent my professional opinion.

Date: March 23, 2021

David C. Hawkins, Consulting Arborist

Certified Arborist: Mass. Arborists Association MCA#1425

International Society of Arboriculture

Board Certified Master Arborist ISA# NE-0541-B

Licensed Arborist: Rhode Island Department of

Environmental Management RI # 696

Member: American Society of Consulting Arborists

Member: The Tree Care Industry

Tree Risk Assessment Qualification (TRAQ)

International Society of Arboriculture March 2014

Renewed Oct. 2018

Mass. Tree Wardens and Foresters Assoc.


Executive Board Member



NOTE: RETAINING WALL MATERIAL TO BE UNILOCK "BRUSSSELS DIMENSIONAL SYSTEM", COLOR SHOWN IS LIMESTONE





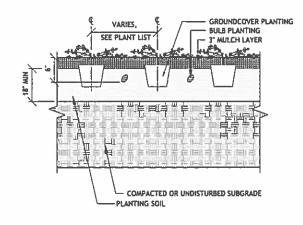

PERENNIAL, GROUNDCOVER & BULB PLANTING (4) FERLINGUE 1'-1'-0"



6 KETAHANA **RETAINING WALL**

PLANT LIST

5 PLANT LIST SCALE: NTS PLANT LIST

	SYMBOL TREES	QUANTITY	SIZE	BOTANICAL NAME	COMMON NAME	REMARKS	CHARACTERISTICS				
ı	AC	10	6-8' HT	ABIES CONCOLOR	WHITE FIR	B&B, HEAVY					
ľ	AG	5	5-6' HT	AMELANCHIER GRANDIFLORA "AUTUMN BRILLIANCE"	AUTUMN BRILLIANCE AMELANCHIER	MULTISTEMMED, HEAVY	WHITE, APRIL. FRUIT. FALL COLOR				
ŀ	СС	9	2-21 CAL	CARPINUS CAROLINIANA	AMERICAN HORNBEAM	B&B	WHITE, FEB. FALL COLOR				
	CE	1	2{-3" CAL	CERCIS CANADENSIS "APPALACHIAN RED"	APPALACHIAN RED EASTERN REDBUD	B&B, HEAVY, SPECIMEN	FUSCIA PINK, APRIL. FALL COLOR				
1	JV	3	6-8' HT	JUNIPERUS VIRGINIANA	RED CEDAR	BGB, HEAVY					
	MG	3	8-10' HT	METASEQUOIA GLYPTOSTROBOIDES	DAWN REDWOOD	B&B, SPECIMEN					
	MV	3	7-8' HT	MAGNOLIA VIRGINIANA "MOONGLOW"	MOONGLOW SWEETBAY MAGNOLIA	TREE FORM	WHITE, MAY-JUNE. FRUIT				
1	NS	5	2-21 CAL	NYSSA SYLVATICA	BLACK TUPELO	B&B, SPECIMEN					
1	PS	16	6-8' HT	PINUS STROBUS	EASTERN WHITE PINE	B&B, HEAVY					
1	QP	15	21-3" CAL	QUERCUS PALUSTRIS	PIN OAK	B&B, SPECIMEN					
	QR	7	2-2}" CAL	QUERCUS RUBRA	RED OAK	BEB					
	SHRUBS										
	8B	10	3 GAL	BUDDLEJA "BLUE CHIP LOW AND BEHOLD"	BLUE CHIP LO AND BEHOLD BUTTERFLYBUSH	MATCHED	BLUE, JUNE- SEPT.				
	со	11	3 GAL	CEPHALANTHUS OCCIDENTALIS	BUTTONBUSH	MATCHED	WHITE, JUNE				
	CA	42	3 GAL	CLETHRA ALNIFOLIA "HUMMINGBIRD"	HUMMINGBIRD SWEET PEPPERBUSH	MATCHED	WHITE, JULY-AUGUST				
1	CS	13	3 GAL	CORNUS SERICEA "ARCTIC	ARCTIC FIRE RED-TWIG		CREAM-WHITE, MAY-JUNE				
1				FIRE	DOGWOOD	MATCHED					
	HQ	14	5 GAL	HYDRANGEA QUERCIFOLIA "SNOW QUEEN"	SNOW QUEEN OAKLEAF HYDRANGEA	MATCHED	WHITE-PINK, MAY-JULY				
1	IC	6	3 GAL	ILEX CRENETA"STEEDS"	STEEDS JAPANESE HOLLY						
	RK	15	3 GAL	ROSA "WHITE KNOCKOUT"	WHITE KNOCKOUT ROSE	SPECIMEN	WHITE, MAY-FROST				
GROUNDCOVER AND PERENNIALS											
	НВ	51	1 GAL	HEMEROCALLIS "BIG TIME HAPPY"	BIG TIME HAPPY DAYLILY	24" OC, TRI. SP.	LEMON YELLOW, SP-FALL				
	NR	46	1 GAL	NEPETA RACEMOSA "WALKERS LOW"	WALKER'S LOW CATMINT	24" OC, TRI. SP.	LAVENDER, APRIL-SEPT.				
	VM	422	1 QT	VINCA MINOR "BOWLES"	BOWLES PERIWINKLE	18° OC, TRI. SP.	JUNE. EVERGREEN				

2" DIAMETER PAINTED STEEL PIPE STAKE

GUY WIRE

SEE LAYOUT AND

PLAN FOR ADJACENT MATERIALS

DECIDUOUS TREE PLANTING

SCALE: 1"=1"-0"

2" DIAMETER PAINTED STEEL PIPE STAKE

GUY WIRE

SEE LAYOUT AND


MATERIALS
PLAN FOR ADJACENT
MATERIALS

EVERGREEN TREE PLANTING

SCALE: 1"=1"-0"

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Zoning Board of Appeals

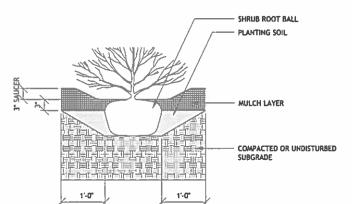

SHRUB PLANTING DETAIL SCALE: 17=1'-0"

Catherine Oranchak / Landscape Architect Prenning, Bosiga and Construction 122 Sunset Rood, Arington, Massochusetts 02474 9 781 752 8678 W www.gethermoranchek.com

NOTE
1. SET ROOT FLARE 2" ABOVE
FINISHED GRADE
SET ROOTBALL ON UNDISTURBED
SUBGRADE

TREE WRAP

3" MULCH LAYER

NOTE: 1. SET ROOT FLARE 2" ABOVE

MULCH LAYER

6° HIGH SAUCER

- PLANTING SOIL

SLOPED PLANTED
SURFACE

1. SET NOOT FLARE 2" ABOVE FINISHED GRADE 2. SET ROOTBALL ON UNDISTURBED SUBGRADE 3. CENTER ROOT FLARE AT AVERAGE SLOPE GRADIENT

6" HIGH SAUCER

PLANTING SOIL

No. Description Date DWG ISSUE & REVISION HISTORY

Project Title: PRENTICE **PLACE**

GRAFTON, MASSACHUSETTS


Key Plan

PLANTING **DETAILS**

Project No 21-002 Scole: VARIES Drawn By do Checked By do Approved By clo Date: 4/14/21

Drawing No.

L 1.2

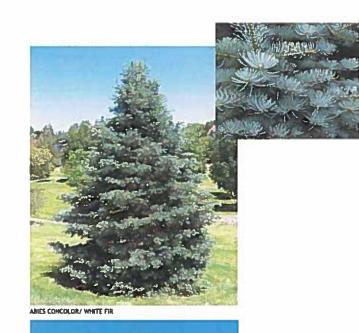









PINUS STROBUS/ EASTERN WHITE PINE

1 PLANT LIST
SCALE: NTS

Catherine Oranchak / Landscape Architect

Pleantag, Besign end Constructive 122 Sunset Read, Arington, Massachusetts 02474 9 781 782 8879 Www.cathereparachak.com

No. Description

DWG ISSUE & REVISION HISTORY

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Key Plan

PRENTICE PLACE

GRAFTON, MASSACHUSETTS

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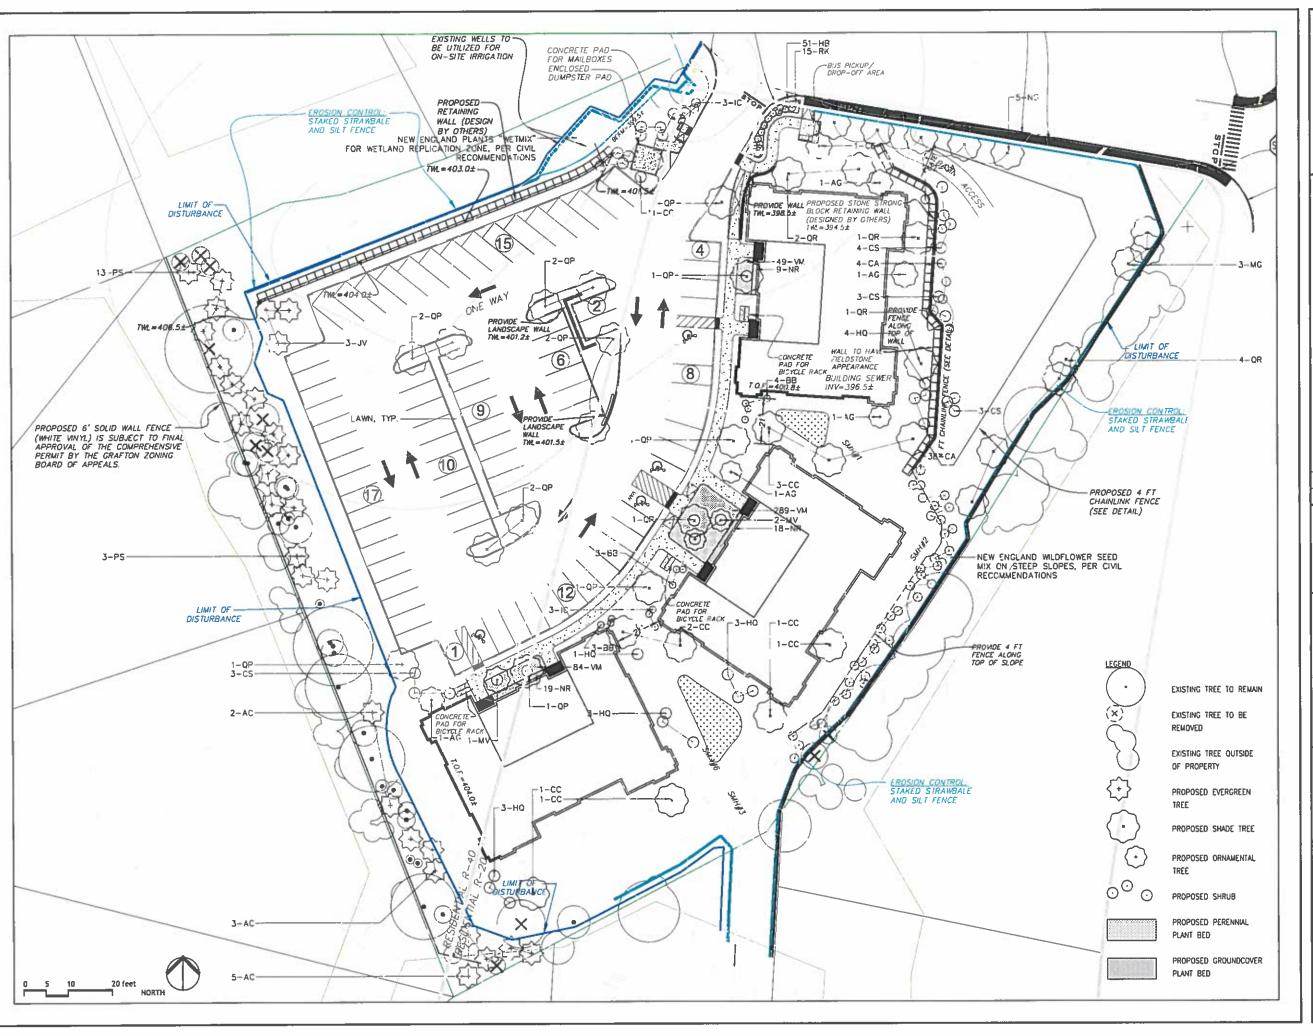
PLANT IMAGES

Project No. 21-002 Scole: VARIES
Drawn By clo
Checked By clo

Approved By cla Date: 4/14/21

Drawing No.

L 1.3



Catherine Oranchak / Landscape Architect

Pleantsp. Freign set Coastruction 122 Sunset Rood, Affordon, Moreochusetts 02474 † 761 752 8879 Week-cutherneuranchos.com

1. ALL AREAS NOT NOTED AS WILDFLOWER SEED OR NEW ENGLAND WETLAND PLANTS "WETMIX" TO BE SEEDED LAWN

No. Description DWG ISSUE & REVISION HISTORY

Date

Key Plan

PRENTICE **PLACE**

GRAFTON, MASSACHUSETTS

PLANTING PLAN

Project No 21-002 Drown By cla

Checked By:cla Approved By Clo Dote: 4/14/21

Drawing No.

L 1.1

Scale: 1" • 20'-0"